


2ND STOREY PLAN
1: 200 (13-STOREY ANCILLARY OFFICE)

NOTES:
THE OCCUPANCY LOAD FOR THIS FLOOR IS - 140 PERSONS
THE NUMBER OF PERSONS PROVIDED WITH MEANS OF ESCAPE - 400 PERSONS
THIS FLOOR IS PROTECTED WITH AUTOMATIC SPRINKLER SYSTEM,
MANUAL CALL POINT, AUTOMATIC FIRE ALARM BELL, FIRE EXTINGUISHERS,
HOBSPRINK & SMOKESTOP.

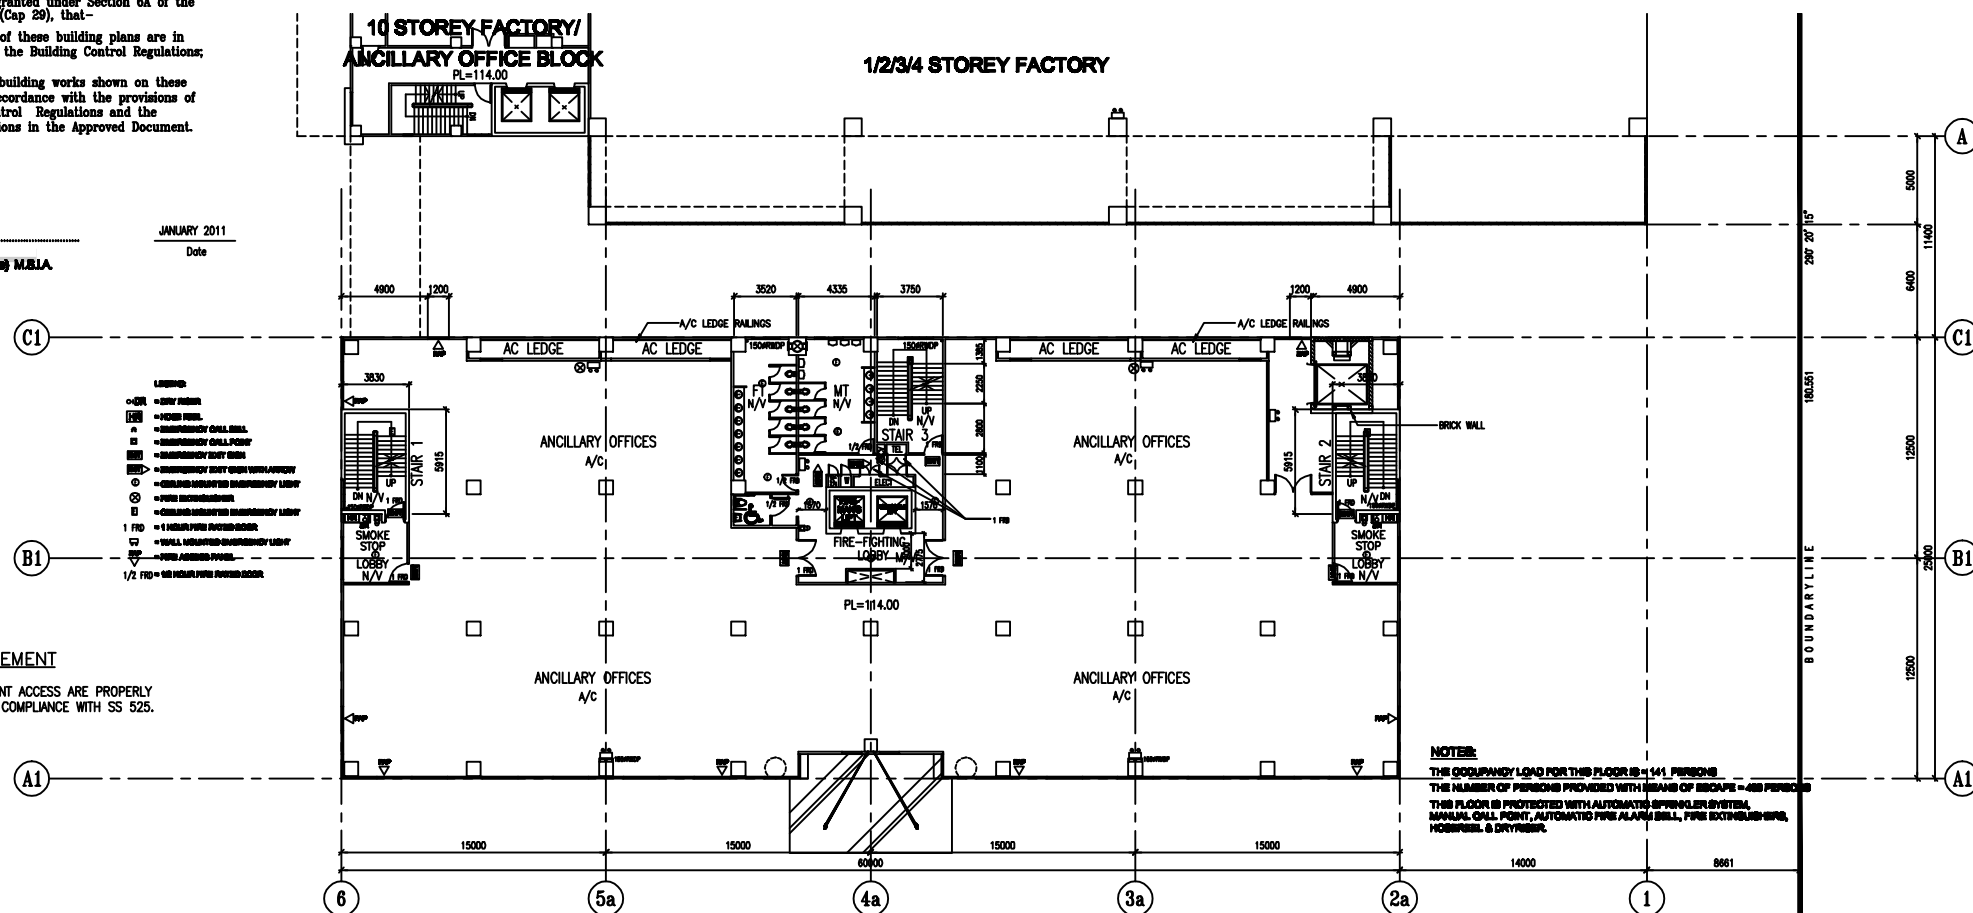

3RD STOREY PLAN
1: 200 (13-STOREY ANCILLARY OFFICE)

NOTES:
THE OCCUPANCY LOAD FOR THIS FLOOR IS - 141 PERSONS
THE NUMBER OF PERSONS PROVIDED WITH MEANS OF ESCAPE - 400 PERSONS
THIS FLOOR IS PROTECTED WITH AUTOMATIC SPRINKLER SYSTEM,
MANUAL CALL POINT, AUTOMATIC FIRE ALARM BELL, FIRE EXTINGUISHERS,
HOBSPRINK & SMOKESTOP.

I, _____, NRIC No. _____, being a qualified person, hereby certify that the building works and fire safety works as shown on these plans have been designed in accordance with the provisions of the Code of Practice for Fire Precautions in Buildings 2007, including all amendments applicable up to the date of this submission, the Fire Safety Act and its Regulations, the relevant code of practice or designed guidelines, subject to waivers granted under Section 27 of the Act.

I, _____, hereby certify, subject to any waiver/modification granted under Section 6A of the Building Control Act (Cap 29), that:-

- the preparation of these building plans are in accordance with the Building Control Regulations; and
- the buildings / building works shown on these plans are in accordance with the provisions of the Building Control Regulations and the acceptable solutions in the Approved Document.

JANUARY 2011
Date

B.Arch.(ppm) M.S.A.

- LEGEND**
- - FIRE ALARM
 - - FIRE HORN
 - △ - EMERGENCY CALL BELL
 - - EMERGENCY CALL POINT
 - - EMERGENCY EXIT SIGN
 - - EMERGENCY EXIT SIGN WITH ARROW
 - - BUILDING ISOLATED EMERGENCY LIGHT
 - - FIRE EXTINGUISHER
 - - CHARGED ISOLATED EMERGENCY LIGHT
 - 1 FID - 1 HOUR FIRE RESISTANCE
 - 1/2 FID - 1/2 HOUR FIRE RESISTANCE
 - - WALL MOUNTED EMERGENCY LIGHT
 - - FIRE ARMED POINT
 - 1/2 FID - 1/2 HOUR FIRE RESISTANCE

EHD REQUIREMENT

SAFE AND PERMANENT ACCESS ARE PROPERLY PROVIDED AND THE COMPLIANCE WITH SS 525.

03 sheet of 40

Project Ref No : A903-00002-2003-BP01

TENURE OF LAND:
GOVERNMENT LAND SALES (URAHDB)

Rev.	Date	Amendment	By
2	JULY 2006	ADDITIONAL GOODS LIFT	
1	JUN 2006	SDV, TEL SERVICES	

Lessee's Signature & Address


SYSLAND PTE. LTD.
NO. 30 TUAS BAY DRIVE
SINGAPORE 637548

Project
**PROPOSED ERECTION OF
1/2/3/4-STOREY FACTORY, 13-STOREY
ANCILLARY OFFICE BLOCK AND
10-STOREY FACTORY/ANCILLARY
OFFICE BLOCK ON LOT 03338L (OLD LOT
2890A-PT) MK07 AT TUAS BAY DRIVE
(TUAS PLANNING AREA)**

Drawing Description
**(13-STOREY ANCILLARY OFFICE)
2ND STOREY PLAN
3RD STOREY PLAN**

Date: JANUARY 2011 Scale: 1 : 200
Drawn: TL Designed: BP Checked:

Drawing No: TSJ/01-039/A03 Rev. No: 1
THIS DRAWING IS COPYRIGHT RESERVED

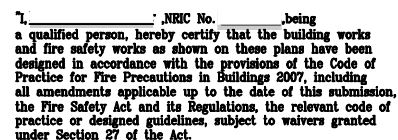

I, _____, hereby certify, subject to any waiver/modification granted under Section 6A of the Building Control Act (Cap 29), that-

- a) the preparation of these building plans are in accordance with the Building Control Regulations; and
- b) the buildings / building works shown on these plans are in accordance with the provisions of the Building Control Regulations and the acceptable solutions in the Approved Document.

Barth Spont M.S.A.

JANUARY 2011
Date



SAFE AND PERMANENT ACCESS ARE PROPERLY PROVIDED AND THE COMPLIANCE WITH SS 525.

0 4 8 12 16 20 MET
SCALE = 1:250

TENURE OF LAND:
GOVERNMENT LAND SALES (URA/HDB)

2	JULY 2006	ADDITIONAL GOODS LIFT	
1	JUN 2006	SCV, TEL SERVICES	
Rev.	Date	Amendment	By

DATE	DATE	DATE
Lessee's Signature & Address		

SYSLAND PTE. LTD.
NO. 30 TUAS BAY DRIVE
SINGAPORE 637548

Project

**PROPOSED ERECTION OF
1/2/3/4-STOREY FACTORY, 13-STOREY
ANCILLARY OFFICE BLOCK AND
10-STOREY FACTORY/ANCILLARY
OFFICE BLOCK ON LOT 03338L (OLD LOT
2890A-PT) MK07 AT TUAS BAY DRIVE
(TUAS PLANNING AREA)**

Drawing Description

(13-STOREY ANCILLARY OFFICE)
4TH STOREY PLAN
5TH,6TH,8TH,9TH & 11TH STOREY PLAN

Date: JANUARY 2011	Scale: 1 : 200
--------------------	----------------

Drawn: TL	Designed: BP	Checked:
-----------	--------------	----------

Drawing No: TSJ/01-039/A04	Rev. No:	
----------------------------	----------	--

THIS DRAWING IS COPYRIGHT RESERVED



- [illegible]



Thermal conductivity of metal roof (0.50-1.00) assumed 0.80 W/mK	=	0.81
Thermal conductivity of 75mm glass wool insulation 0.040	=	0.040
Roof slope 0.007 (2.5% rise in 300mm run)	=	0.145
R ₀ (slope roof) 0.001 (rise in 300mm run)	=	0.001
R _u (0.001 rise in 300mm run)	=	0.002
$R_T = R_0 + \frac{R_{0.001}}{241} + R_u + R_i$		
$= 0.002 + \frac{0.001}{241} + \frac{0.001}{0.002} + 0.145 + 0.002$	=	2.000
$U = \frac{1}{R_T}$	=	0.500 W/m ² K

DENSITY OF CONCRETE = 2400 KG/M³ FOR THE R.C. SLAB ROOF

$$\begin{aligned}
 U &= \frac{1}{N} \\
 NT &= N_0 + \frac{N_1}{N} + \frac{N_2}{N} + \dots + \frac{N_N}{N} \\
 &= 0.0005 + 0.75\% + 0.75\% + 0.75\% + 0.0005 + 0.75\% \\
 &= 1.5005 \\
 U &= \frac{1}{NT} \\
 &= \frac{1}{1.5005} \\
 &= 0.6664
 \end{aligned}$$

I, _____, NRIC No. _____, being
a qualified person, hereby certify that the building works
and fire safety works as shown on these plans have been
designed in accordance with the provisions of the Code of
Practice for Fire Precautions in Buildings 2007, including
all amendments applicable up to the date of this submission,
the Fire Safety Act and its Regulations, the relevant code of
practice or designed guidelines, subject to waivers granted
under Section 27 of the Act.

"I, _____, hereby certify, subject to any waiver/modification granted under Section 6A of the Building Control Act (Cap 29), that-

- a) the preparation of these building plans are in accordance with the Building Control Regulations; and
- b) the buildings / building works shown on these plans are in accordance with the provisions of the Building Control Regulations and the acceptable solutions in the Approved Document.

JANUARY 2011
Date

B.Arch.(Spore) M.S.I.A.

EHD REQUIREMENT

SAFE AND PERMANENT ACCESS ARE PROPERLY PROVIDED AND THE COMPLIANCE WITH SS 525.



Lessee's Signature & Address
--

Lessor's Signature & Address	Lessee's Signature & Address
---	---

SYSLAND PTE. LTD.
NO. 30 TUAS BAY DRIVE
SINGAPORE 637548

Project	
---------	--

**PROPOSED ERECTION OF
1/2/3/4-STORY FACTORY, 13-STORY
ANCILLARY OFFICE BLOCK AND
10-STORY FACTORY/ANCILLARY
OFFICE BLOCK ON LOT 03338L (OLD LOT
2000A-PT) MK07 AT TUAS BAY DRIVE
(TUAS PLANNING AREA)**

9	Drawing Description
---	---------------------

(13-STOREY ANCILLARY OFFICE)
10TH STOREY PLAN
METAL ROOF DETAIL
R.C. FLAT ROOF DETAIL

Date: JANUARY 2011		Scale: 1 : 200
Drawn: TL	Designed: BP	Checked: TSJ

Drawing No: TSJ/01-039/A04a	Rev. No:	1
-----------------------------	----------	---

THIS DRAWING IS COPYRIGHT RESERVED



7. _____, NRIC No. _____, being a qualified person, hereby certify that the building works and fire safety works as shown on these plans have been designed in accordance with the provisions of the Code of Practice for Fire Precautions in Buildings 2007, including all amendments applicable up to the date of this submission, the Fire Safety Act and its Regulations, the relevant code of practice or designed guidelines, subject to waivers granted under Section 27 of the Act.

7. _____, hereby certify, subject to any waiver/modification granted under Section 6A of the Building Control Act (Cap 29), that-

- a) the preparation of these building plans are in accordance with the Building Control Regulations; and
- b) the buildings / building works shown on these plans are in accordance with the provisions of the Building Control Regulations and the acceptable solutions in the Approved Document.

JANUARY 2011
Date

B.Arch.(Sports) M.S.I.A.

NOTE:
THE OCCUPANCY LOAD FOR THIS FLOOR IS - 148 PERSONS
THE NUMBER OF PERSONS PROVIDED WITH MEANS OF ESCAPE - 488 PERSONS
THIS FLOOR IS PROTECTED WITH AUTOMATIC SPRINKLER SYSTEM,
MANUAL CALL POINT, AUTOMATIC FIRE ALARM BELL, FIRE EXTINGUISHERS,
HOSEREEL & DRYPIPE.



06 sheet of 40

Project Ref No : A903-00002-2003-BP01

TENURE OF LAND:
GOVERNMENT LAND SALES (URA/HDB)

2	JULY 2006	ADDITIONAL GOODS LIFT	
1	JUN 2006	SCV, TEL. SERVICES	
Rev.	Date	Amendment	By

Lessee's Signature & Address

SYSLAND PTE. LTD.
NO. 30 TUAS BAY DRIVE
SINGAPORE 637548

Project

**PROPOSED ERECTION OF
1/2/3/4-STORY FACTORY, 13-STORY
ANCILLARY OFFICE BLOCK AND
10-STORY FACTORY/ANCILLARY
OFFICE BLOCK ON LOT 03338L (OLD LOT
2890A-PT) MK07 AT TUAS BAY DRIVE
(TUAS PLANNING AREA)**

Drawing	Description
(13-STOREY ANCILLARY OFFICE)	
7TH STOREY PLAN	
12TH,13TH STOREY PLAN	

Date: JANUARY 2011		Scale: 1 : 200	
Drawn: TL	Designed: BP	Checked:	

Drawing No: TSJ/01-039/A05	Rev. No: 1
THIS DRAWING IS COPYRIGHT RESERVED	



NOTES:
THE OCCUPANCY LOAD FOR THIS FLOOR IS - 148 PERSONS
THE NUMBER OF PERSONS PROVIDED WITH MEANS OF ESCAPE - 488 PERSONS
THIS FLOOR IS PROTECTED WITH AUTOMATIC SPRINKLER SYSTEM,
MANUAL CALL POINT, AUTOMATIC FIRE ALARM BELL, FIRE EXTINGUISHERS,
HOSEREEL & DRYRISER.

- LEGEND:**
-  = DOOR
 -  = WINDOW
 -  = EMERGENCY CALL BELL
 -  = EMERGENCY CALL POINT
 -  = EMERGENCY EXIT DOOR
 -  = EMERGENCY EXIT DOOR WITH ALARM
 -  = CEILING MOUNTED EMERGENCY LIGHT
 -  = FIRE EXTINGUISHER
 -  = CEILING MOUNTED EMERGENCY LIGHT
- 1 FRO** = 1 HOUR FIRE RATED DOOR
-  = WALL MOUNTED EMERGENCY LIGHT
-  = FIRE ALARM PANEL
- 1/2 FRO** = 1/2 HOUR FIRE RATED DOOR

7. _____, NRIC No. _____, being a qualified person, hereby certify that the building works and fire safety works as shown on these plans have been designed in accordance with the provisions of the Code of Practice for Fire Precautions in Buildings 2007, including all amendments applicable up to the date of this submission, the Fire Safety Act and its Regulations, the relevant code of practice or designed guidelines, subject to waivers granted under Section 27 of the Act.

7. _____, hereby certify, subject to any waiver/modification granted under Section 6A of the Building Control Act (Cap 29), that-

- a) the preparation of these building plans are in accordance with the Building Control Regulations; and
- b) the buildings / building works shown on these plans are in accordance with the provisions of the Building Control Regulations and the acceptable solutions in the Approved Document.

B.Arch. (S'pore) M.S.L.A.



TENURE OF LAND:
GOVERNMENT LAND SALES (URA/HDB)

Rev.	Date	Amendment	By
------	------	-----------	----

Lessee's Signature & Address

SYSLAND PTE. LTD.
NO. 30 TUAS BAY DRIVE
SINGAPORE 637548

Project
PROPOSED ERECTION OF
1/2/3/4-STOREY FACTORY, 13-STOREY
ANCILLARY OFFICE BLOCK AND
10-STOREY FACTORY/ANCILLARY
OFFICE BLOCK ON LOT 03338L (OLD LOT
2290A-PT) MK07 AT TUAS BAY DRIVE
(TUAS PLANNING AREA)

(13-STOREY ANCILLARY OFFICE)
13TH STOREY PLAN

Date: JANUARY 2011	Scale: 1 : 200	
Drawn: TL	Designed: BP	Checked:

Drawing No: TSJ/01-039/A05a	Rev. No:	1
THIS DRAWING IS COPYRIGHT RESERVED		

EHD REQUIREMENT

SAFE AND PERMANENT ACCESS ARE PROPERLY PROVIDED AND THE COMPLIANCE WITH SS 525.

GOVERNMENT LAND SALES (URAHDB)

Rev.	Date	Amendment	By
2	JUN 2006	SDV, TEL SERVICES	
1	SEPT 2005	REVISED WATER TANK SIZE AND LOCATION	

Lessee's Signature & Address

SYSLAND PTE. LTD.
NO. 30 TUAS BAY DRIVE
SINGAPORE 637548

Project
**PROPOSED ERECTION OF
1/234-STORY FACTORY, 13-STORY
ANCILLARY OFFICE BLOCK AND
10-STORY FACTORY/ANCILLARY
OFFICE BLOCK ON LOT 03338L (OLD LOT
2890A-PT) MK07 AT TUAS BAY DRIVE
(TUAS PLANNING AREA)**

Drawing Description

**(13-STORY ANCILLARY OFFICE)
ROOF PLAN
UPPER ROOF PLAN**

Date: JANUARY 2011 Scale: 1 : 200
Drawn: TL Designed: BP Checked:

I, _____, NRIC No. _____, being a qualified person, hereby certify that the building works and fire safety works as shown on these plans have been designed in accordance with the provisions of the Code of Practice for Fire Precautions in Buildings 2007, including all amendments applicable up to the date of this submission, the Fire Safety Act and its Regulations, the relevant code of practice or designed guidelines, subject to waivers granted under Section 27 of the Act.

I, _____, hereby certify, subject to any waiver/modification granted under Section 6A of the Building Control Act (Cap 29), that
a) the preparation of these building plans are in accordance with the Building Control Regulations; and
b) the buildings / building works shown on these plans are in accordance with the provisions of the Building Control Regulations and the acceptable solutions in the Approved Document.

S.Arch./Spon. M.B.L.A.

JANUARY 2011
Date

ROOF PLAN

1 : 200 (13-STORY ANCILLARY OFFICE)

NOTES:
THE OCCUPANCY LOAD FOR THIS FLOOR IS = 148
THE NUMBER OF PERSONS PROVIDED WITH MEANS OF ESCAPE = 408
THIS FLOOR IS PROTECTED WITH AUTOMATIC SPRINKLER SYSTEM, MANUAL CALL POINT, AUTOMATIC FIRE ALARM BELL, FIRE EXTINGUISHERS, HOSEREEL & DRYPIPE.

UPPER ROOF PLAN

1 : 200 (13-STORY ANCILLARY OFFICE)

0 4 8 12 16 20 METRES
SCALE = 1 : 200